Establishing the Public Participation Policy for the Edison Subarea Committee Public Meetings

To ensure fair and equitable public participation during Edison Subarea's Committee meetings, the following policies are hereby established:

- 1. All meetings shall be open to the public.
- 2. A public comment period shall be observed during the meetings.

To aid in the Committee's desire to adequately deliberate all issues, public comments shall be taken both in person/writing at the meetings and oral public comments are encouraged to be limited to three (3) minutes. Formal written comments should be directed to:

Skagit Planning and Development Center 1800 Continental Place Mount Vernon WA 98273 ATTN: Edison Subarea

Establishing the Date, Time, and Location of the Edison Subarea Committee Meetings

The regular monthly meetings of the Edison Clean Water Subarea Committee are hereby set as follows

Date: The Fourth (4th) Wednesday of each month

Time: 5:00 PM

Location: Teacher/Staff Room, Edison Elementary School

Establishing the Posting Locations for the Edison Subarea Public Meetings

Any alterations to the time or location of the Subarea Committee meetings and other public notices shall be posted in the following manner:

- 1. Skagit County Website
- 2. Bow Post Office
- 3. County Administrative Office
- 4. Edison Community Bulletin Board Corner of McTaggart and Main

Establishing the Official Newspaper for Public Notices Required to be Formally Published


The official newspaper for required public notices shall be the Skagit Valley Herald.

A Policy Regarding Wastewater Connection Schematics and Standards

The attached wastewater connection schematics and standards are hereby adopted to include the following:

- 1. Residential/Commercial Gravity Tank Installations
- 2. Residential/Commercial Pump Tank (STEP) Installations
- 3. Commercial Grease Trap Installations

Residential/Commercial Gravity Tank Installation

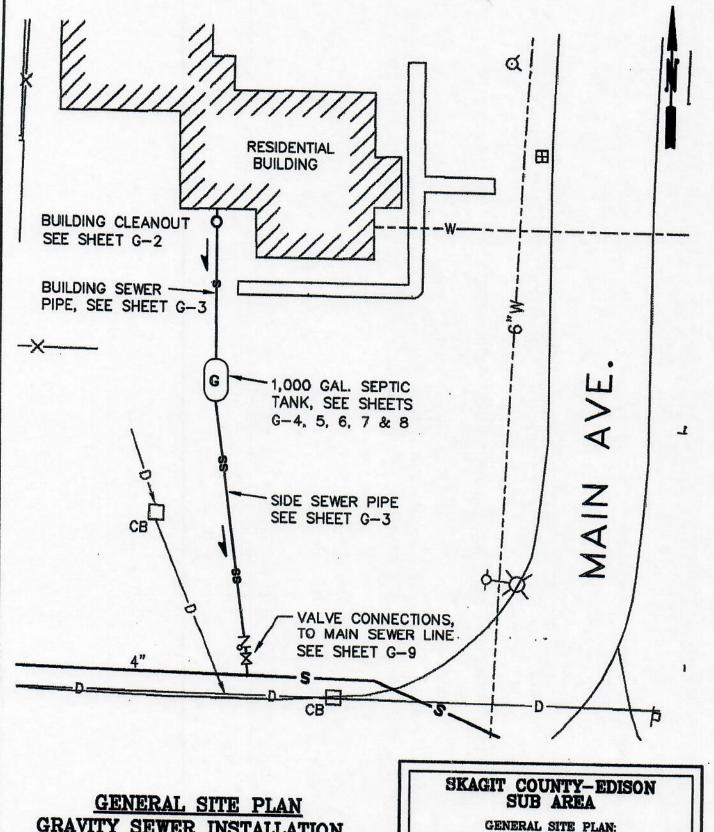

GRAVITY SEWER INSTALLATION SCALE: 1"=20'

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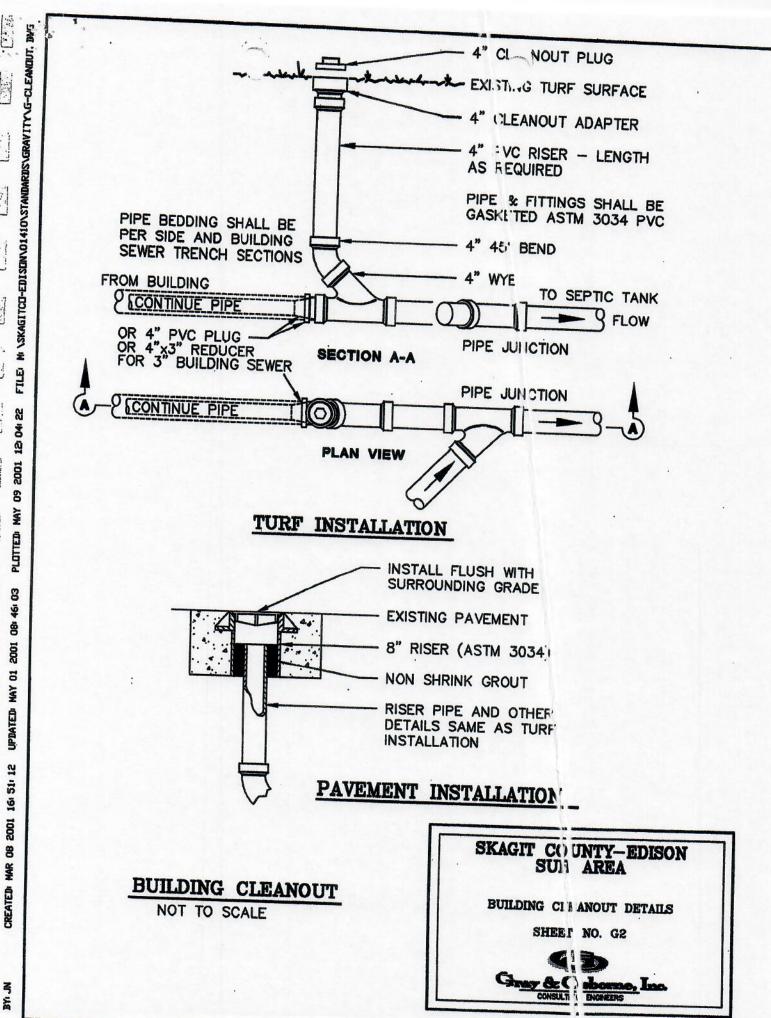
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BY: JN

RESIDENTIAL GRAVITY SEWER INSTALLATION





SECTION

TURF

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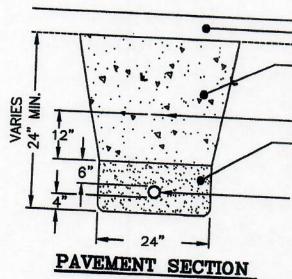
TURF RESTORATION

NATIVE MATERIAL FREE OF ALL DEBRIS AND ROCKS OVER 3" IN THE GREATEST DIMENSION

DETECTABLE TAPE MARKED SEWER BEDDING MATERIAL FOR FLEXIBLE PIPE CONFORMING TO WSDOT STD SPECIFICATIONS, SECTION 9-03.16 2", 3" OR 4" SEWER PIPE

NOTE:

THE 2", 3" AND 4" SEWER PIPE AND FITTINGS SHALL BE PVC CONFORMING TO ASTM 3034 PVC



PAVEMENT RESTORATION

BANK RUN GRAVEL FOR TRENCH BACKFILL CONFORMING TO WSDOT STD SPECIFICATION SECTION 9-13.9 DETECTABLE TAPE MARKED SEWER

BEDDING MATERIAL FOR FLEXIBLE PIPE CONFORMING TO WSDOT STD SPECIFICATIONS, SECTION 9-03.16

2", 3" OR 4" SEWER PIPE

TRENCH SECTIONS


NOT TO SCALE

SKAGIT COUNTY-EDISON SUB AREA

TRENCH SECTIONS FOR BUILDING AND SIDE SEWERS



BY

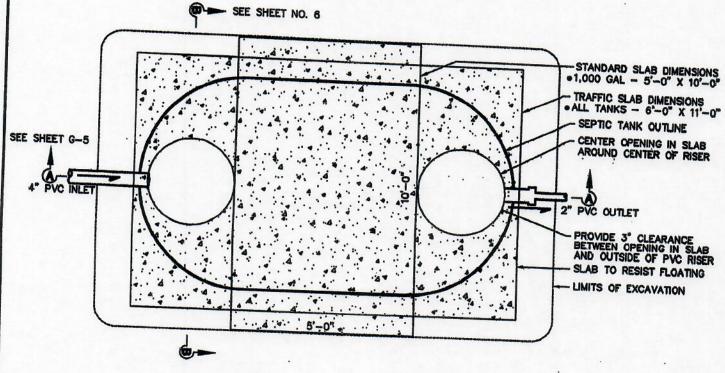

SEE SHEET G-7 FOR TRAFFIC SLAB DETAILS

1,000 GALLON SEPTIC TANK PLAN

NOT TO SCALE

SKAGIT COUNTY-EDISON SUB AREA

1,000 GALLON SEPTIC TANK PLAN: GRAVITY CONNECTION



BOLTDOWN FIBERGLASS LID, STAINLESS BOLTS, BOLT TO RISER-TO LID ADAPTER, SET FLUSH TO FINAL GROUND SURFACE ATTACH RISER EXTENSION WITH GRADE RING INSERT - FINISHED GROUND SURFACE Install 24" PVC Grade Ring On Existing Riser to Reach The Finished Ground Level ATTACH RISER EXTENSION WITH GRADE RING INSERT FACTORY INSTALLED RISER (24" RIBBED PVC, 12" LONG) EXTEND HANDLE TO WITHIN 12" OF FIBERGLASS LID CONCRETE SLAB - SEE TABLE. ON SHEET G-8 FOR THICKNESS 4" PVC BUILDING SEWER &. 1,000 GALLON REINFORCED FIBERGLASS SEPTIC TANK WITH 12" TALL RISER, PIPE GROMMET FOR DISCHARCE PIPING AND ELECTRICAL J-BOX INLET INVERT 2" SEWER 24 HOUR STORAGE (125± GALLONS) 4"x 2" PVC ECCENTRIC REDUCER (SxS) TANK OUTLET ELEV PER PLAN 4" EFFLUENT FILTER, ORENCO BIOTUBE PART NO. FT0444-3 OR APPROVED EQUAL SEE SHEET G-7 FOR TRAFFIC SLAB DETAILS

1,000 GALLON SEPTIC TANK - SECTION A/A

NOT TO SCALE

SKAGIT COUNTY-EDISON SUB AREA

1,000 GALLON SEPTIC TANK SECTION-A/A
GRAVITY CONNECTION

SHEET NO. G5



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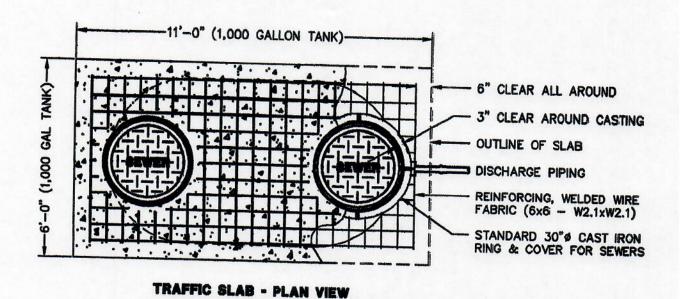
1,000 GALLON SEPTIC TANK SECTION - B/B
NOT TO SCALE


M:\SKAGITCO\0!4!0\STANDARDS\GRAVITY\G-TANK-SEC-B.DWG, LAYOUTI, 04/26/02 10:33:37 AM, 1:1.03688, BY: M. NEUBAUER

SKAGIT COUNTY-EDISON SUB AREA

1,000 GALLON SEPTIC TANK SECTION—B/B FILL AND COMPACTION GRAVITY CONNECTION SHEET NO. G6





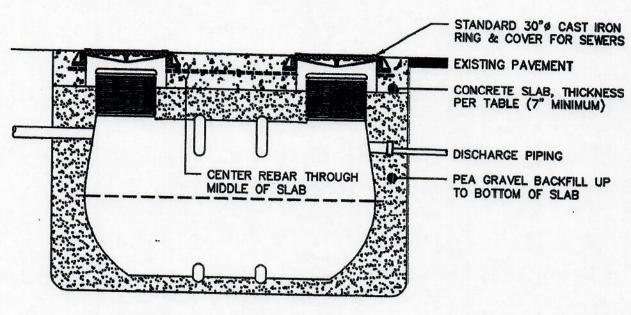

TRAFFIC SLAB - ELEVATION VIEW

SKAGIT COUNTY-EDISON SUB AREA

TRAFFIC SLAB DETAILS 1,000 GALLON SEPTIC TANK SHEET NO. G?



1,000 GALLON SEPTIC TANK

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BY: JN


| NON-TRAFFIC CONDITIONS (5'x10' SLAB) | | TRAFFIC CONDITIONS (6'x11' SLAB) | |
|--|---|--|---|
| DEPTH OF COVER OVER CONC. SLAB (FEET) | MIN. CONC. SLAB THICKNESS (INCHES) | DEPTH OF COVER OVER CONC. SLAB (FEET) | MIN. CONC. SLAB THICKNESS (INCHES) |
| 0.50 | 15.0 | 0.50 | 13.80 |
| 0.75 | 13.5 | 0.75 | 12.30 |
| 1.00 | 12.0 | 1.00 | 10.9 |
| 1.25 | 10.1 | 1.25 | 9.40 |
| 1.50 | 8.6 | 1.50 | 8.00 (E)) |
| 1.75 | 7.4 | | |
| 2.00 | 6.0 (A) | | |

- (A) MINIMUM THICKNESS FOR NON-TRAFFIC RATED SLAB IS 6 IN CHES.
- (B) MINIMUM THICKNESS FOR TRAFFIC RATED SLAB IS 8 INCHES.

SKAGIT COUNTY-ED SON SUB AREA

SEPTIC TANK ANCHORING



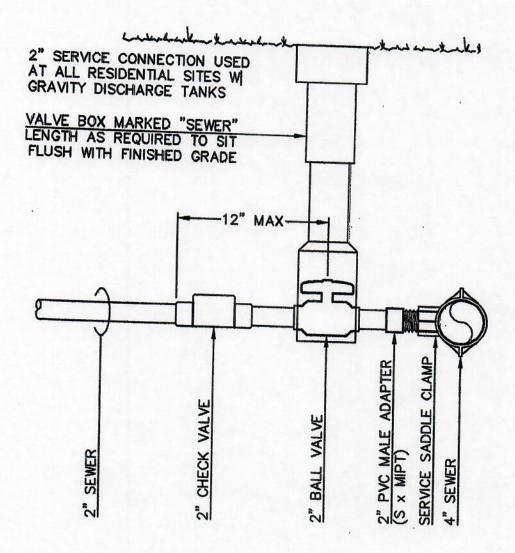

VALVE CONNECTIONS


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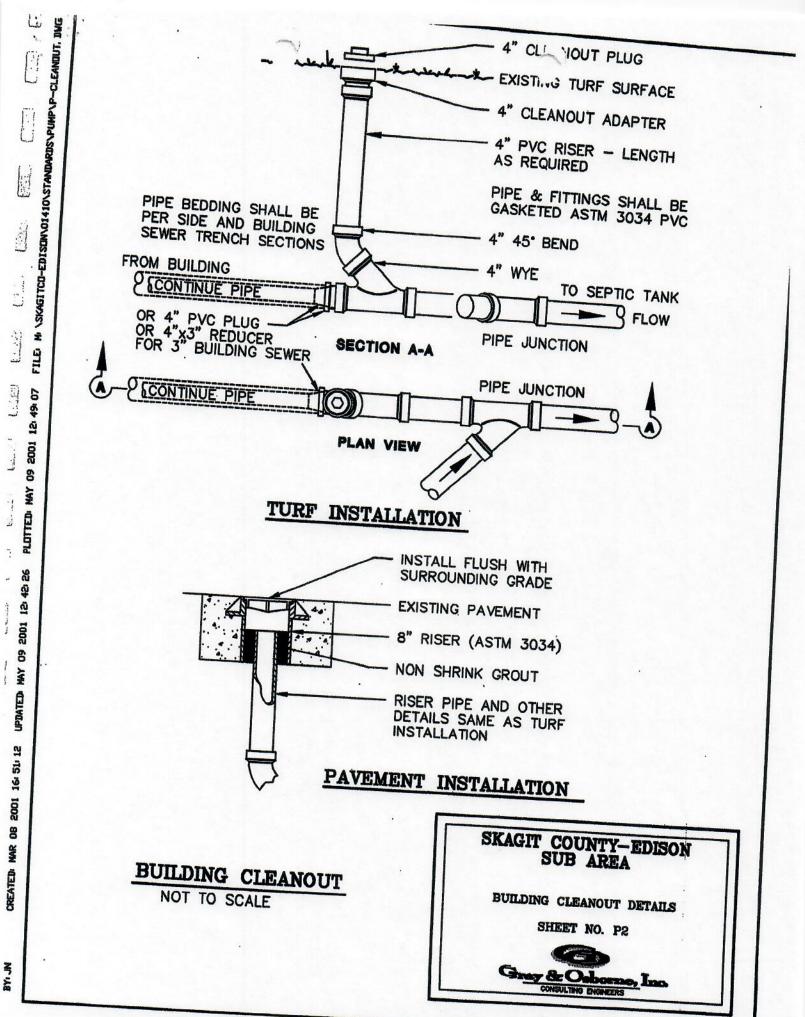
SKAGIT COUNTY-EDISON SUB AREA

VALVE CONNECTIONS GRAVITY CONNECTION



Residential/Commercial Pump Tank (STEP) Installation



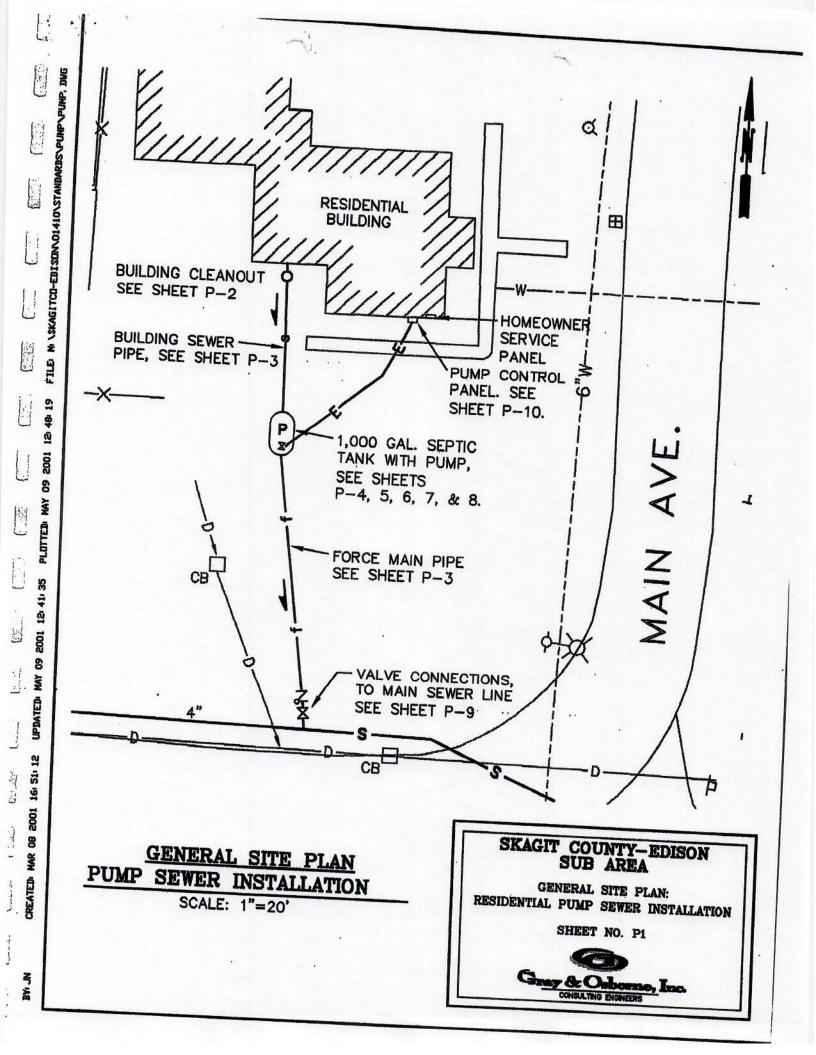

TURF SECTION

TURF RESTORATION

NATIVE MATERIAL FREE OF ALL DEBRIS AND ROCKS OVER 3" IN THE GREATEST DIMENSION

DETECTABLE TAPE MARKED SEWER

BEDDING MATERIAL FOR FLEXIBLE


PIPE CONFORMING TO WSDOT STD

SPECIFICATIONS, SECTION 9-03.16

1", 2", 3" OR 4" SEWER PIPE

NOTE:

THE 1", 2", 3" AND 4" SEWER PIPE AND FITTINGS SHALL BE PVC CONFORMING TO ASTM 3034 PVC

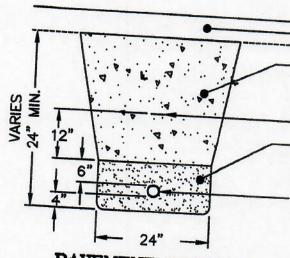

PAVEMENT RESTORATION

BANK RUN GRAVEL FOR TRENCH BACKFILL CONFORMING TO WSDOT STD SPECIFICATION SECTION 9-13.9

DETECTABLE TAPE MARKED SEWER

BEDDING MATERIAL FOR FLEXIBLE

PIPE CONFORMING TO WSDOT STD

SPECIFICATIONS, SECTION 9-03.16

1", 2", 3" OR 4" SEWER PIPE

PAVEMENT SECTION


TRENCH SECTIONS

NOT TO SCALE

SKAGIT COUNTY-EDISON SUB AREA

TRENCH SECTIONS FOR BUILDING AND SIDE SEWERS



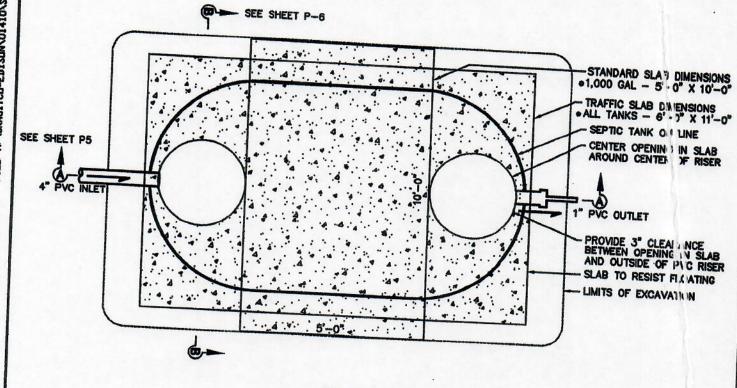


SEE SHEET P-7 FOR TRAFFIC SLAB DETAILS

1,000 GALLON SEPTIC TANK PLAN NOT TO SCALE

SKAGIT COUNTY-EDISON SUB AREA

1,000 GALLON SEPTIC TANK PLAN: PUMP CONNECTION



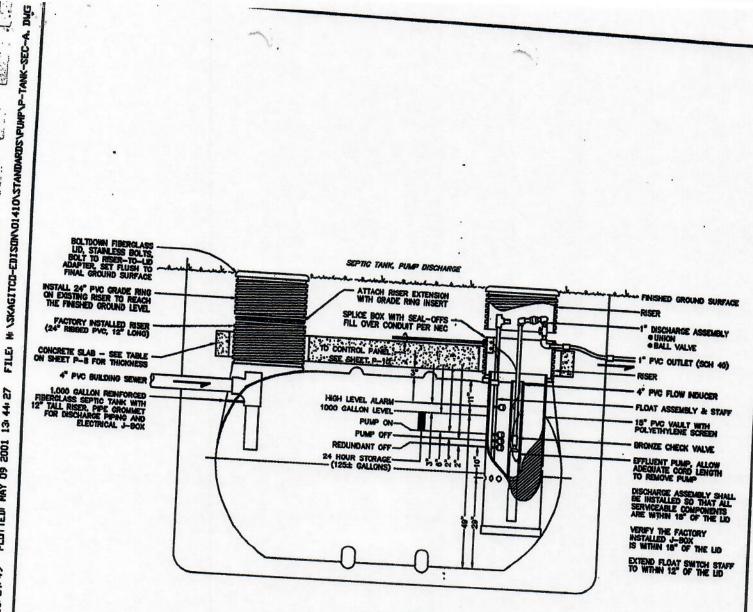

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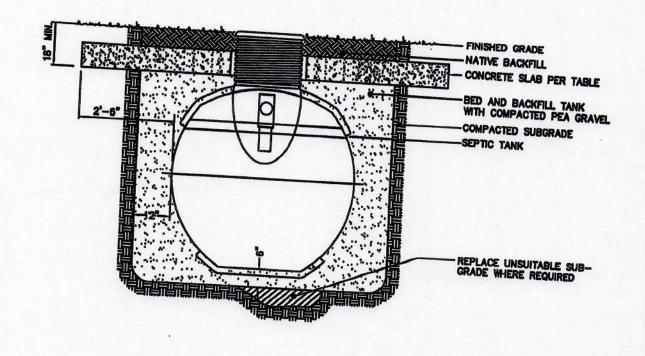
SEE SHEET P-7 FOR TRAFFIC SLAB DETAILS

1,000 GALLON SEPTIC TANK - SECTION A/A NOT TO SCALE

SKAGIT COUNTY-EDISON SUB AREA

1,000 GALLON SEPTIC TANK SECTION-A/A PUMP CONNECTION





1,000 GALLON SEPTIC TANK SECTION - B/B
NOT TO SCALE

SKAGIT COUNTY-EDISON SUB AREA

1,000 GALLON SEPTIC TANK SECTION—B/B
FILL AND COMPACTION
PUMP CONNECTION
SHEET NO. P6



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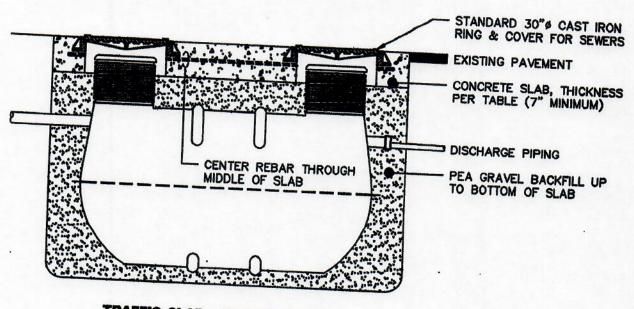
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BY: MNAGEL

6" CLEAR ALL AROUND 3" CLEAR AROUND CASTING OUTLINE OF SLAB DISCHARGE PIPING REINFORCING, WELDED WIRE FABRIC (6x6 - W2.1xW2.1) STANDARD 30" CAST IRON RING & COVER FOR SEWERS



TRAFFIC SLAB - ELEVATION VIEW

SKAGIT COUNTY-EDISON SUB AREA

TRAFFIC SLAB DETAILS 1,000 GALLON SEPTIC TANK SHEET NO. P7



| NON-TRAFFIC CONDITIONS (5'x10' SLAB) | | TRAFFIC CONDITIONS (6'x11' SLAB) | |
|--|---|--|---|
| DEPTH OF COVER OVER CONC. SLAB (FEET) | MIN. CONC. SLAB THICKNESS (INCHES) | DEPTH OF COVER OVER CONC. SLAB (FEET) | MIN. CONC. SLAB THICKNESS (INCHES) |
| 0.50 | 15.0 | 0.50 | 13.80 |
| 0.75 | 13.5 | 0.75 | |
| 1.00 | 12.0 | 1.00 | 12.30 |
| 1.25 | 10.1 | 1.25 | 10.9 |
| 1.50 | 8.6 | 1.50 | 9.40 |
| 1.75 | 7.4 | 1.50 | 8.00 (B) |
| 2.00 | 6.0 (A) | | |

- (A) MINIMUM THICKNESS FOR NON-TRAFFIC RATED SLAB IS 6 INCHES.
- (B) MINIMUM THICKNESS FOR TRAFFIC RATED SLAB IS 8 INCHES.

SKAGIT COUNTY-EDISON SUB AREA

SEPTIC TANK ANCHORING

SHEET NO. P8



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CREATED: MAR 08 2001 16: 51: 12

BY JN

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SKAGIT COUNTY-EDISON SUB AREA

VALVE CONNECTIONS
PUMP CONNECTION


SHEET NO. P9



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SKAGIT COUNTY-EDISON SUB AREA


PUMP CONTROL PANEL ELECTRICAL CONNECTION

SHEET NO. P10

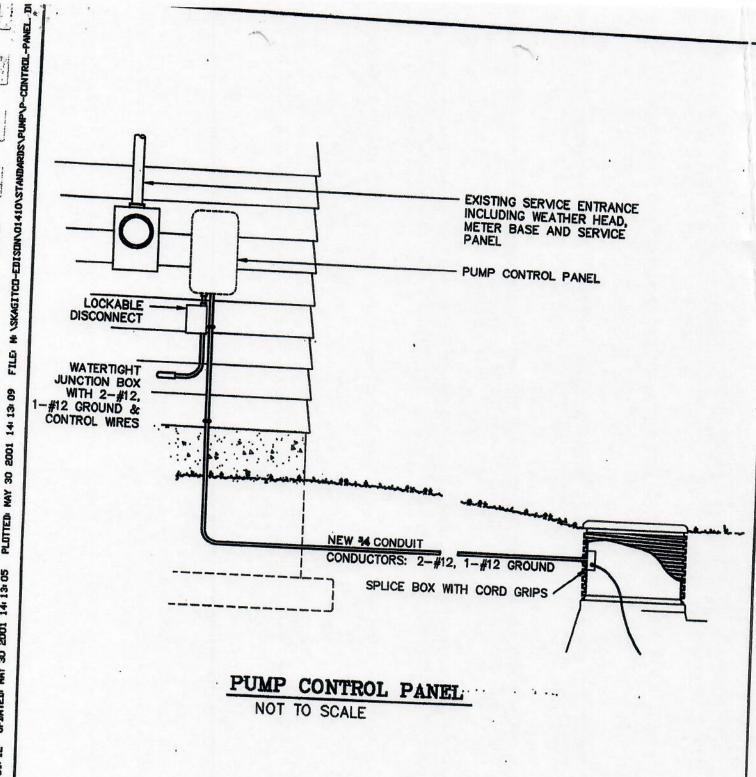

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Commercial Grease Trap Installation

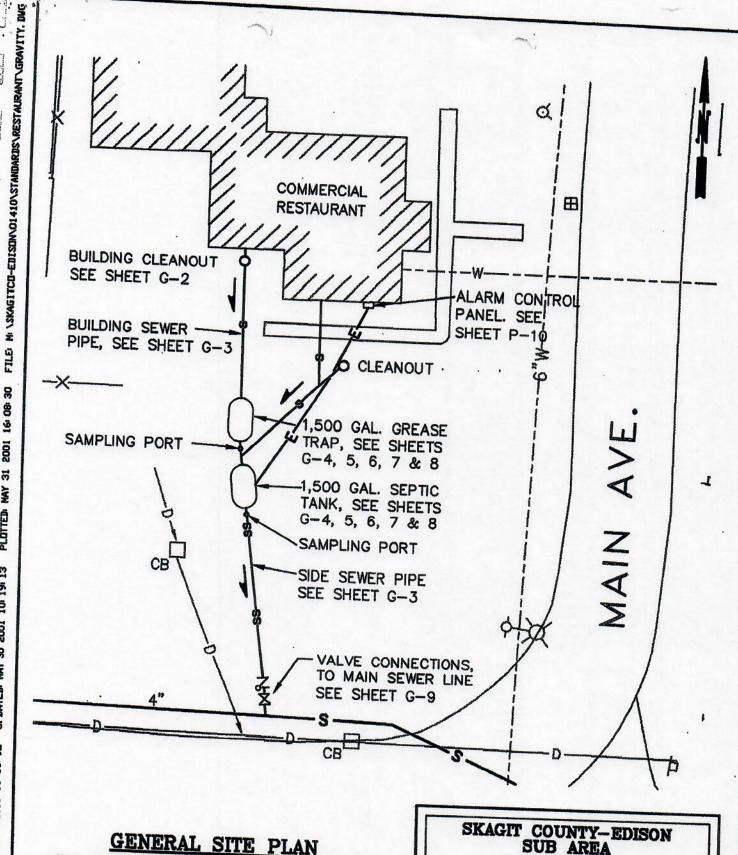

GENERAL SITE PLAN GRAVITY SEWER INSTALLATION

SCALE: 1"=20'

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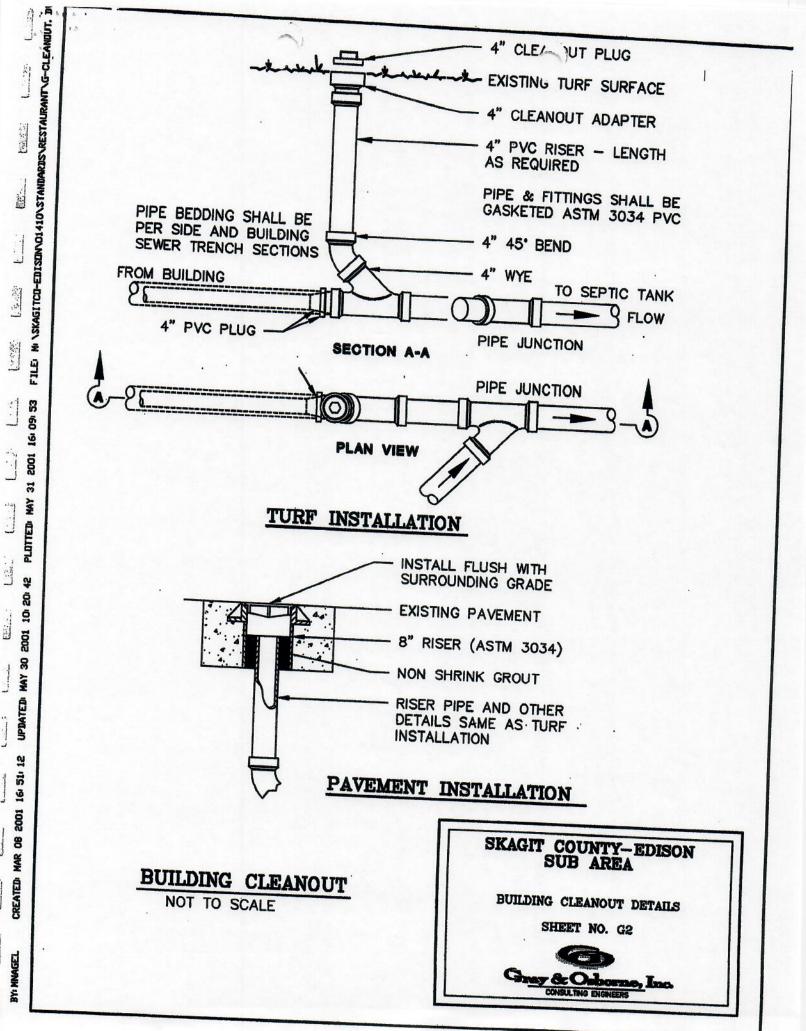
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BY: MNAGEL

GENERAL SITE PLAN: COMMERCIAL RESTUARANT GRAVITY SEWER INSTALLATION SHEET NO. G1





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BY: MNAGEL

TURF RESTORATION

NATIVE MATERIAL FREE OF ALL DEBRIS AND ROCKS OVER 3" IN THE GREATEST DIMENSION DETECTABLE TAPE MARKED SEWER BEDDING MATERIAL FOR FLEXIBLE PIPE CONFORMING TO WSDOT STD SPECIFICATIONS, SECTION 9-03.16

4" SEWER PIPE

NOTE: SEWER PIPE AND FITTINGS SHALL BE PVC CONFORMING TO ASTM 3034 PVC

VARIES 24" MIN 6 24" PAVEMENT SECTION

PAVEMENT RESTORATION

BANK RUN GRAVEL FOR TRENCH BACKFILL CONFORMING TO WSDOT STD SPECIFICATION SECTION 9-13.9

DETECTABLE TAPE MARKED SEWER BEDDING MATERIAL FOR FLEXIBLE PIPE CONFORMING TO WSDOT STD SPECIFICATIONS, SECTION 9-03.16

4" SEWER PIPE

TRENCH SECTIONS

NOT TO SCALE

SKAGIT COUNTY-EDISON SUB AREA

TRENCH SECTIONS FOR BUILDING AND SIDE SEWERS



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BY: MNAGEL

SEE SHEET G-6

STANDARD SLAB DIMENSIONS
1.500 GAL - 7-0" X 11"-4"
TRAFFIC SLAB DIMENSIONS
ALL TANKS - 6"-7" X 13"-4"
SEPTIC TANK OUTLINE
CENTER OPENING IN SLAB
AROUND CENTER OF RISER
4" PVC INLET

PROVIDE 3" CLEARANCE
BETWEEN OPENING IN SLAB
AND OUTSIDE OF PVC RISER
SLAB TO RESIST FLOATING
LIMITS OF EXCAVATION


SEE SHEET G-7 FOR TRAFFIC SLAB DETAILS

1,500 GALLON SEPTIC TANK PLAN NOT TO SCALE

SKAGIT COUNTY-EDISON SUB AREA

1,500 GALLON SEPTIC TANK PLAN: COMMERCIAL RESTAURANT



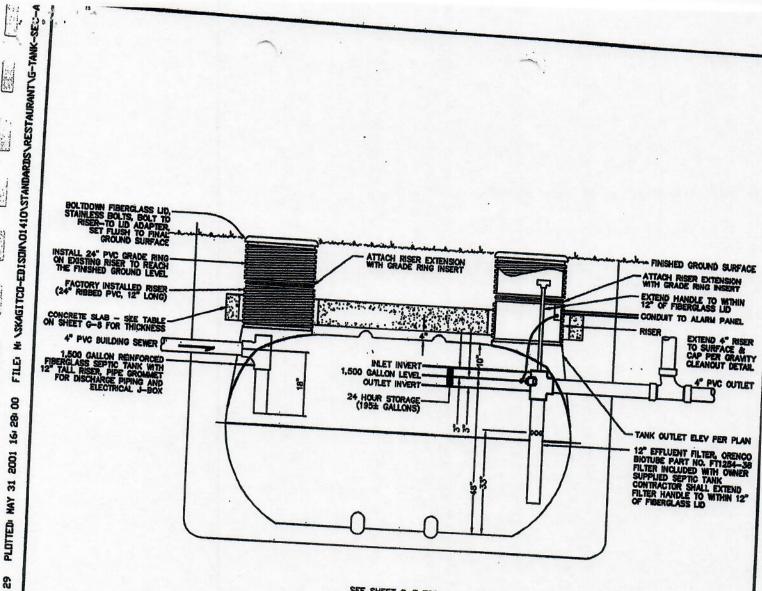

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SEE SHEET G-7 FOR TRAFFIC SLAB DETAILS


1,500 GALLON SEPTIC TANK - SECTION A/A NOT TO SCALE

SKAGIT COUNTY-EDISON SUB AREA

1,500 GALLON SEPTIC TANK SECTION-A/A COMMERCIAL RESTAURANT



. 18.6

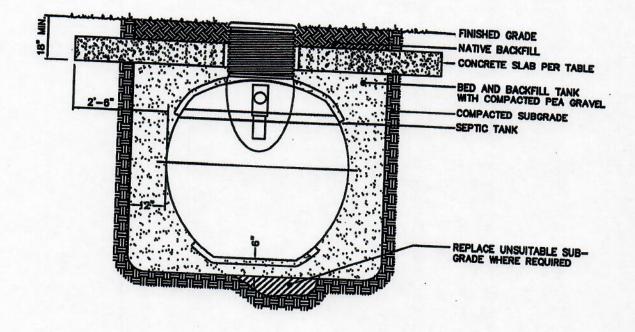

1,500 GALLON SEPTIC TANK SECTION - B/B
NOT TO SCALE

SKAGIT COUNTY-EDISON SUB AREA

1,500 GALLON SEPTIC TANK SECTION—B/B FILL AND COMPACTION COMMERCIAL RESTAURANT SHEET NO. G6



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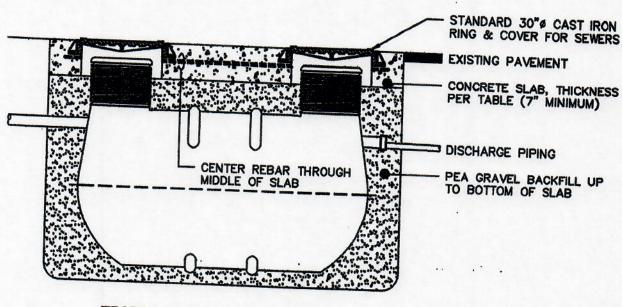
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TRAFFIC SLAB - ELEVATION VIEW

SKAGIT COUNTY-EDISON SUB AREA

TRAFFIC SLAB DETAILS COMMERCIAL RESTAURANT SHEET NO. G7



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| 6'-4"x13'-4" CONCRETE SLAB | | | | |
|--|---|--|--|--|
| DEPTH OF COVER OVER CONC. SLAB (FEET) | MIN. CONC. SLAB THICKNESS (INCHES) | | | |
| 0.50 | 13.80 | | | |
| 0.75 | 12.30 | | | |
| 1.00 | 10.9 | | | |
| 1.25 | 9.40 | | | |
| 1.50 | 8.00 | | | |
| 1.75 | 6.5 (A) | | | |
| 2.00 | 5.1 (B) | | | |

MINIMUM THICKNESS FOR TRAFFIC RATED SLAB IS 8 INCHES.


(A) MINIMUM THICKNESS FOR NON-TRAFFIC RATED SLAB IS 5 INCHES.

SKAGIT COUNTY-EDISON SUB AREA

SEPTIC TANK ANCHORING



A

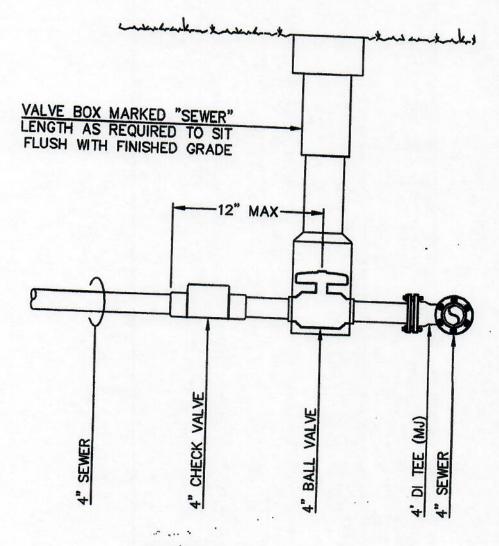


VALVE CONNECTIONS

NOT TO SCALE

SKAGIT COUNTY-EDISON SUB AREA

VALVE CONNECTIONS
COMMERCIAL RESTUARANT CONNECTION



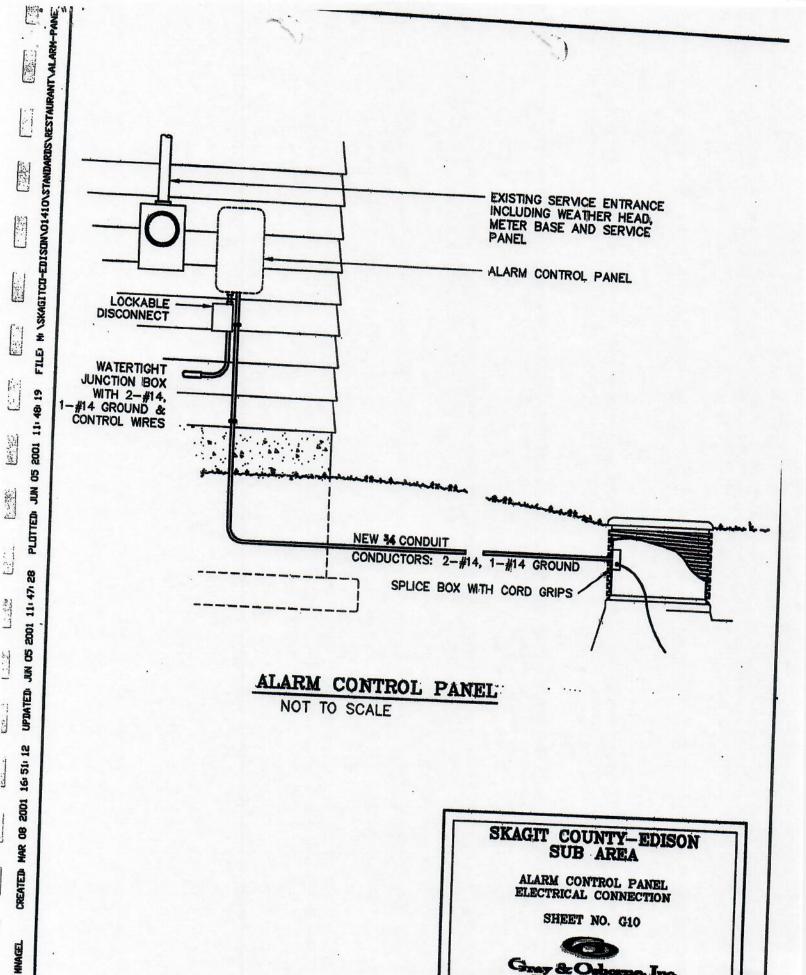

CONSULTING ENGINEERS

Establishing Connection Fees, Charges, and Other Costs

The following connection fees, charges, and other costs are hereby adopted:

- 1. New Commercial Customer First Year Assessment two (2) times the current residential assessment.
- 2. Waste Testing Fee current fee
- 3. New Customer Capital Assessment Fee \$4,035 per ERU
- 4. Plan Review/Inspection Fee current County fee
- 5. Return Inspection Fee \$200.00
- 6. New Connection Insurance Requirement \$100,000
- 7. New Connection Performance Bond 135% of proposed work cost

Policy Related to Commercial Customer Assessments


All commercial customer annual assessments shall be comprised of two (2) components. The first is an ERU-based charge determined by the customer's prior 12-month water usage through June of each year and the second shall be a strength surcharge based on the prior year's periodic BOD and FOG testing conducted by the Subarea.

Due to the frequency and scheduling of the tank testing, the Annual Assessment calculations will include the 4th quarter testing numbers of the prior year and the first three (3) rounds of testing in the current year.

Policy Clarifying the Subarea's Maintenance Responsibilities

The individual customer shall be responsible for all aspects of their wastewater system within their home up to the point where the waste enters the septic/STEP tank and/or grease trap as reflected on the attached drawing.

The Subarea is responsible from the point of waste entry into the septic/STEP tank and/or grease trap until ultimate disposal into the drain field. The ownership and maintenance responsibility of the septic/STEP tank and/or grease trap shall be the Subarea.

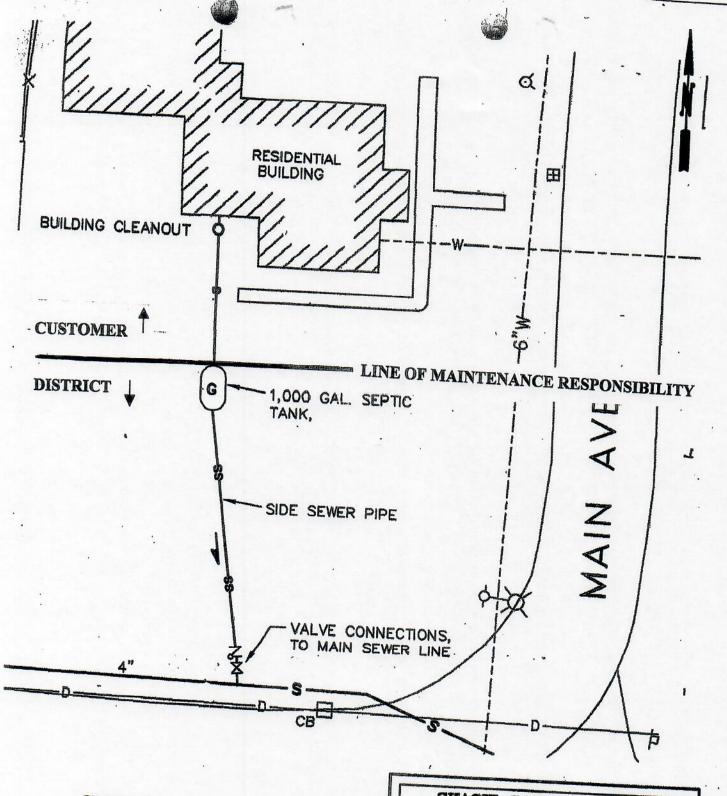

GENERAL SITE PLAN
CUSTOMER AND DISTRICT
MAINTENANCE RESPONSIBILITY

SKAGIT COUNTY-EDISON SUB AREA

GENERAL SITE PLAN: RESIDENTIAL GRAVITY SEWER INSTALLATION

SHEET NO. G1



Establishing Equivalent Residential Unit (ERU), Flow, BOD, and FOG Limits and Standards

The following assumed residential baseline limitations and standards are hereby established:

- 1. Flow shall equal 135 gallons per day (gpd)
- 2. BOD shall be 230 milligrams per liter (mg/L)
- 3. FOG (Fat, Oil, and Grease) shall be 100 milligrams per liter (mg/L)

Policy Limiting the Number and Establishing Annual Assessments for Accessory Dwelling Units (ADU)

Due to the limitations of the Edison Wastewater system, it is the policy of the Edison Subarea to not allow any additional ADUs to be connected to the System over and above the number formally established as of October 2006 unless the owner requesting an ADU currently holds a Future Connection. The new ADU will be required to use half of the Future Connection for this service.

A residential site with an ADU's annual assessments shall be 1.5 times the annual residential assessment. Living space shall be considered to be an ADU if its purpose is to establish independent living characterized by separate kitchen facilities.

ADUs are required to have a separate tank.

Policy Related to Tank Pumping for Sitting Board Members

Since the Edison Subarea Board members serve without compensation and as an inducement for Board membership, it is the policy of the Board to pump sitting Board member's tanks when needed at no charge. The pumping shall occur not more frequently than every five (5) years. For any Board member who has a commercial tank and grease trap, the cost of a residential tank pumping shall be applied against the actual cost of pumping the commercial tank and/or grease trap.

Frequency of Edison School and Commercial Customer Tank and Grease Tank Pumping

The tanks and grease traps of the Edison School and all commercial customers shall be testing quarterly by the maintenance contractor for the Subarea and pumped as needed by the Subarea. The cost of such testing and pumping in one year shall be added to the individual customer's assessments in the subsequent year.

Policy Regarding Future Wastewater Connection and Limiting the Number of Commercial Food Service Establishments

It has been determined that it is in the best interest of the Subarea to both clarify the anticipated use of the existing Future Connections and limit the number of commercial establishments that serve food and/or liquor as follows:

- 1. Future connections can only be activated and connected to the wastewater system if the use will be for a single-family residential purpose or non-food service and non-alcohol service commercial purpose.
- 2. No additional commercial food service and/or liquor sale connections shall be permitted in addition to the number connected to the system as of December 2013.

Policy Regarding Leak Adjustments for Commercial Sites

Since the commercial customer's annual assessment include a component based on water usage, the following policy is adopted related to water leak adjustments when identified:

In the instance where a water leak has been reported by a commercial customer, it is the responsibility of the customer to provide evidence to the Board substantiating the leak and to provide information to determine if the excess water entered the Edison wastewater system.

The confirming information may be in the form of water usage records, copies of repair bills, and/or written confirmation from the plumber who completed the repairs as to whether the leak existed and whether the excess water entered the wast ewater collection system.

If the excess water entered the wastewater collection system, there shall be no adjustment to the customer's assessments. If it was demonstrated that the excess water did not enter the wastewater collection system, the adjustment shall be the difference between the current water usage and that of the same period in the prior year.

Policy Regarding Travel Trailer, RV, or other Similar Connections to the Edison Wastewater System

No travel trailer, recreational vehicle (RV), or similar units may be allowed to be connected to the Edison wastewater system.

Policy Banning the Use of Emulsifying Agents

Due to the inability of the Subarea Wastewater system to chemically or mechanically remove suspended fat, oil, and grease (FOG), all persons and customers are prohibited from using any chemical emulsifying agent for the purpose of hindering or eliminating the interception of fats, oils, or grease prior to entering their septic/STEP tank and/or grease trap.

Policy Related to the Timing and Cost of Pumping Residential Septic/STEP Tanks

In order to facilitate the prompt pumping of residential septic/STEP tanks to ensure the health of the wastewater system, the following procedure shall be followed:

- 1. The systems maintenance contractor shall inform the District Administrator of the need for any residential site's tank to be pumped.
- 2. If the tank to be pumped is one that includes a submersible pump (STEP Tank), due to the difficulty in pumping these tanks and the manpower needed, the Administrator will direct the maintenance contractor to complete the work. The cost of this work shall be paid for by the District and added to the subsequent year's assessment for the customer.
- 3. If the tank to be pumped is for a gravity tank (septic tank), the Administrator shall send a letter to the property owner advising them of the need to pump and the requirements that this be completed within 60 days of the notification.
- 4. If a Tank Pumping Report has not been submitted to the County within this time period, the District shall arrange for the tank to be pumped, the District shall pay this cost and the cost shall be added to the subsequent year's assessment for the customer.